


KEY NOTES

- 1 FA CIRCUIT TO FIVE HEAT DETECTORS BELOW ICE RINK.

GENERAL NOTES


- A. COORDINATE LOCATION AND MOUNTING HEIGHT OF ELECTRICAL DEVICES IN CRAWLSPACE WITH ALL DISCIPLINES AND TRADES PRIOR TO INSTALLATION.
- B. INSTALL CONDUIT WITH NO MORE THAN TWO (2) 90° BENDS BETWEEN PULL BOXES, AND NO MORE THAN 100'-0" (30m) / 30m (100'-0") BETWEEN PULL BOXES. PULL BOXES SHALL BE INSTALLED FOR STRAIGHT THRU PULLS ONLY.
- C. ALL WIRINGS SHALL BE IN CONDUIT.
- D. FIRE ALARM HORN/STROBE SHALL BE MOUNTED ON WALL OF 2ND FLOOR LANDING ONLY. REFER TO RISER DIAGRAM E5.4.
- E. FIRE ALARM DETECTOR SHALL BE MOUNTED ON CEILING OF 3RD FLOOR LANDING ONLY. REFER TO DETAILS.
- F. ELECTRICAL CONTRACTOR SHALL COORDINATE QUANTITIES AND LOCATIONS OF ALL SWITCHES AND VALVES REQUIRING WIRING WITH SPRINKLER CONTRACTOR.
- G. REFER TO FIRE ALARM RISER AND ZONE SCHEDULE FOR INITIATING ZONES AND SIGNAL CIRCUITS.
- H. PROVIDE REVERIFICATION OF FIRE ALARM SYSTEM FOR ALL NEW AND MODIFIED DEVICES.
- I. HEAT DETECTORS WITHIN CRAWLSPACE SHALL BE NON-ADDRESSABLE MOISTURE PROOF TYPE.

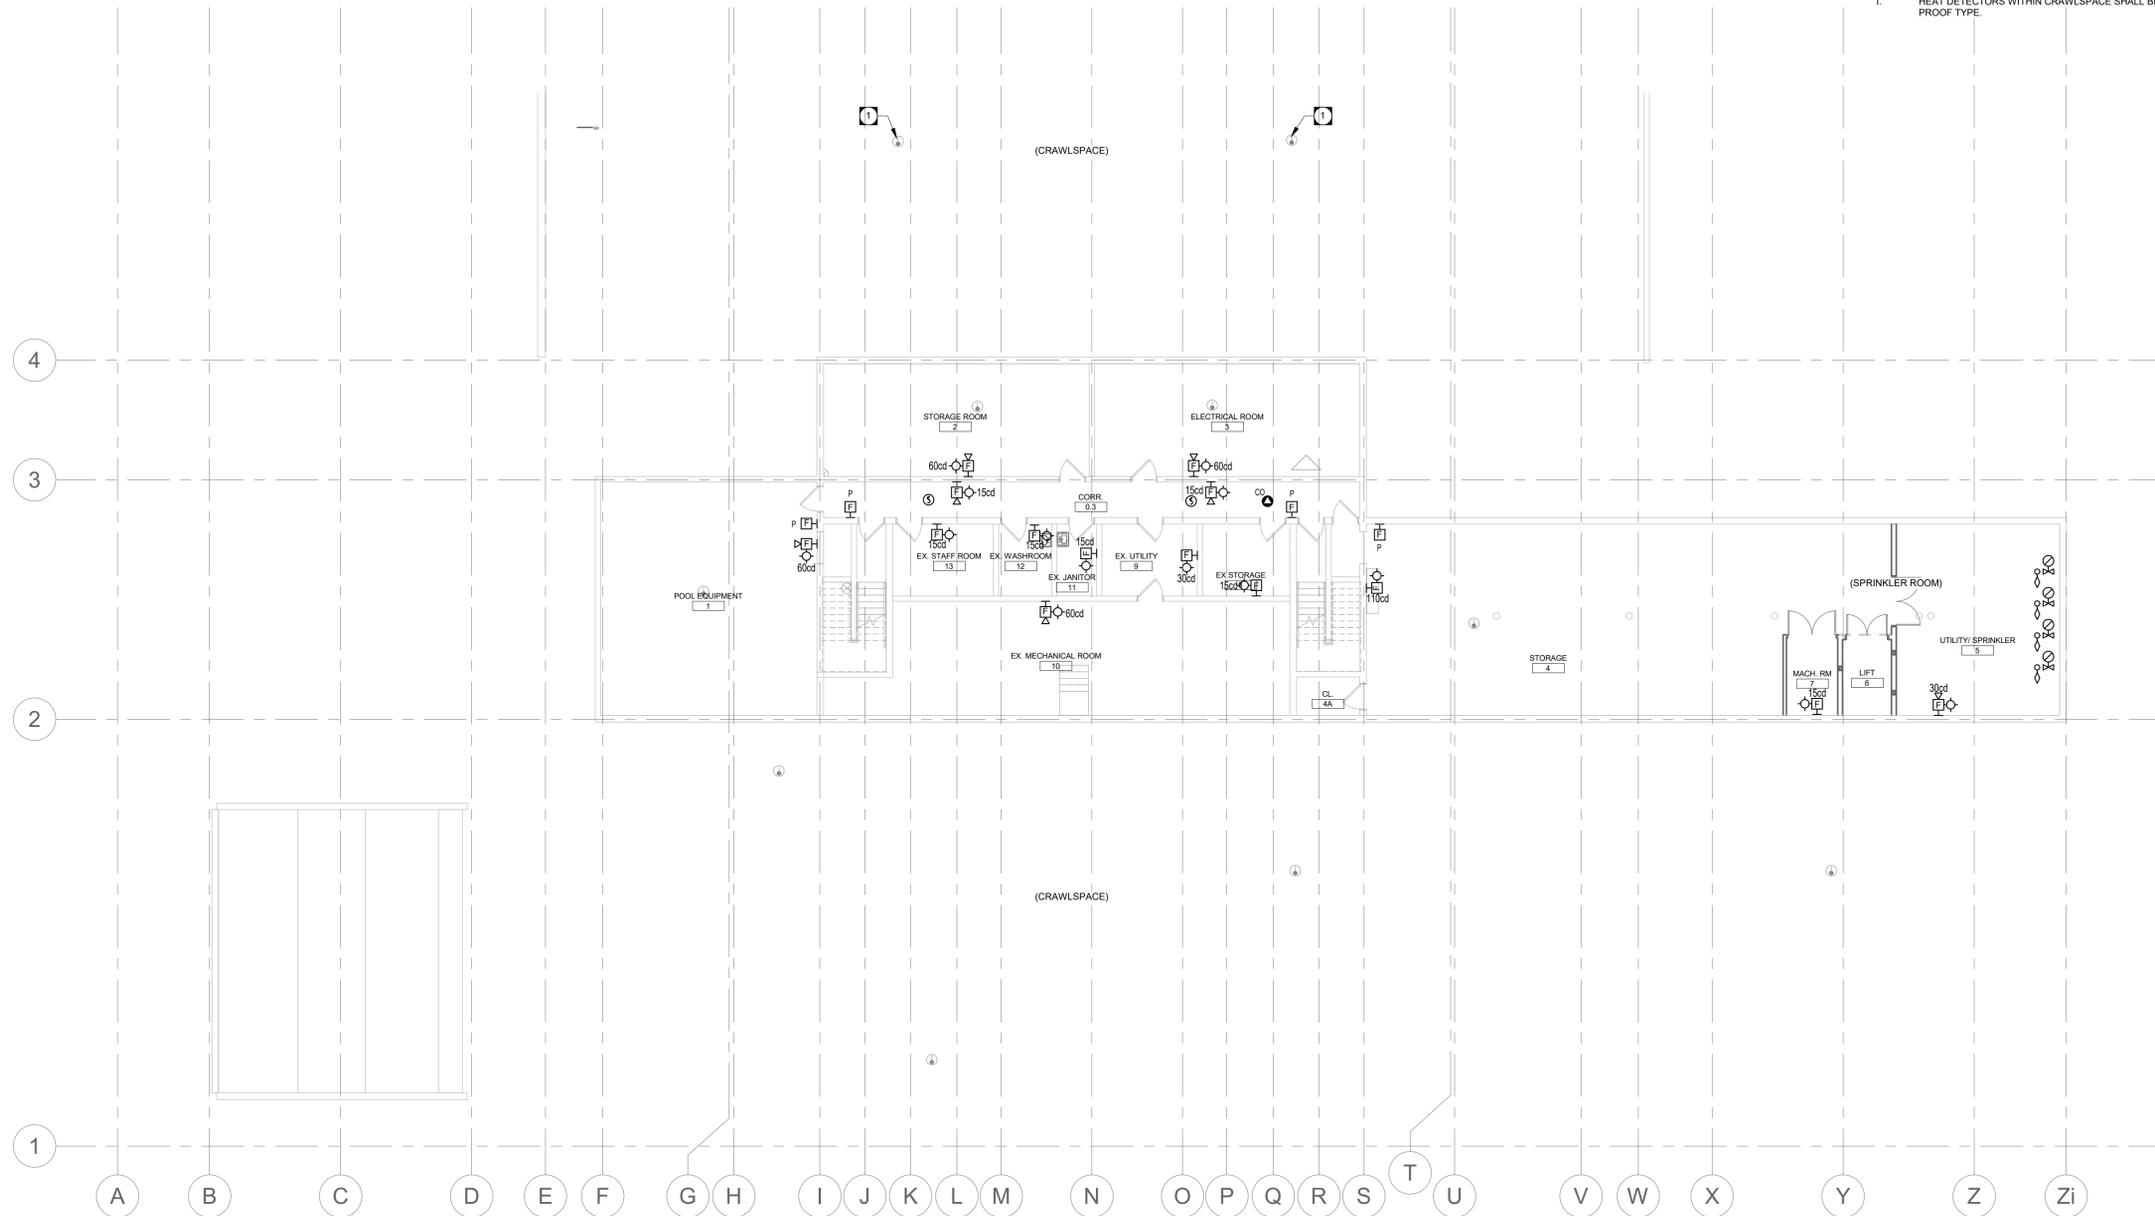

BASEMENT - FIRE ALARM RENOVATION 1
3/32" = 1'-0" EF2.0



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Project
ST. JAMES CIVIC CENTRE

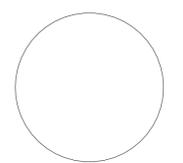Drawing
BASEMENT RENOVATION -
FIRE ALARM PLAN

Drawn By: JA Review By: MP
Scale: As indicated Tender No: 1176-2019
Date: 11/06/19
Sheet: EF2.0